

UNITED STATES DEPARTMENT OF THE INTERIOR S FISH AND WILDLIFF SERVICE


U.S. FISH AND WILDLIFE SERVICE 2013 EXPERIMENTAL CHANNEL PROJECT


SAN MARCOS AQUATIC RESOURCE CENTER


HAYES COUNTY

ASSET #:



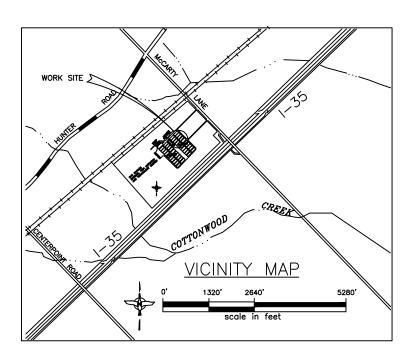

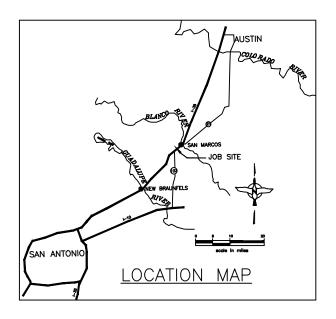

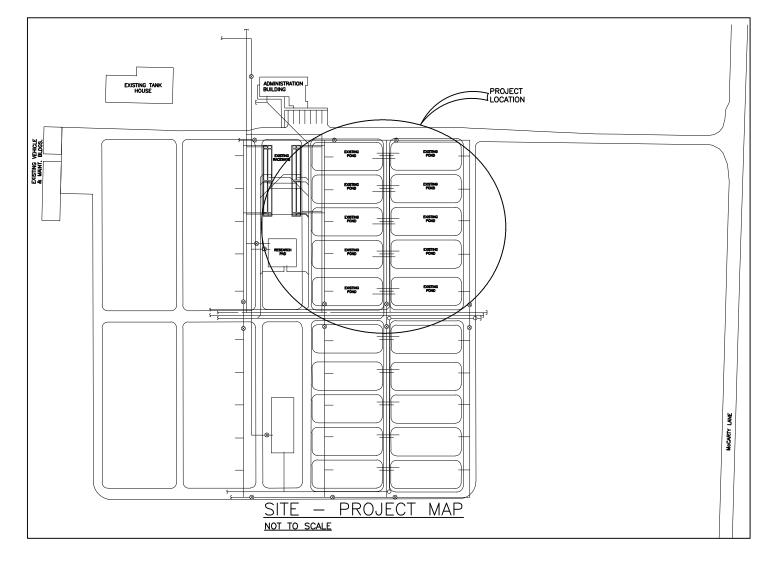

INDEX TO DRAWINGS				
SHT. No.	DRAWING TITLE			
1	MAPS & INDEX OF DRAWINGS			
2	EXISTING LAYOUT			
3	CONCEPTUAL CHANNEL LAYOUT			
4	SECTIONS			

APPROVALS

PROGRAM SUPERVISOR

REGIONAL ENGINEER

PROJECT MANAGER

ENVIRONMENTAL COMPLIANCE

ENERGY COMPLIANCE


CULTURAL RESOURCES


UNITED STATES DEPARTMENT OF THE INTERIOR
U.S. FISH AND WILDLIFE SERVICE
DIVISION OF ENGINEERING


SAN MARCOS AQUATIC RESOURCES CENTER
HAYS COUNTY TEXA

EXPERIMENTAL CHANNEL PROJECT MAPS AND INDEX OF DRAWINGS GENERAL

DESIGN: FREEMAN DRAWN: TOURJEE CHECK: checker
DRAWING FILENAME AND NUMBER DATE: 10/4/2012
PRO-EXIST PIPING PLAN SHT. NO. SEQ. NO.
2F-TX-831-62.0 1 1 of 4

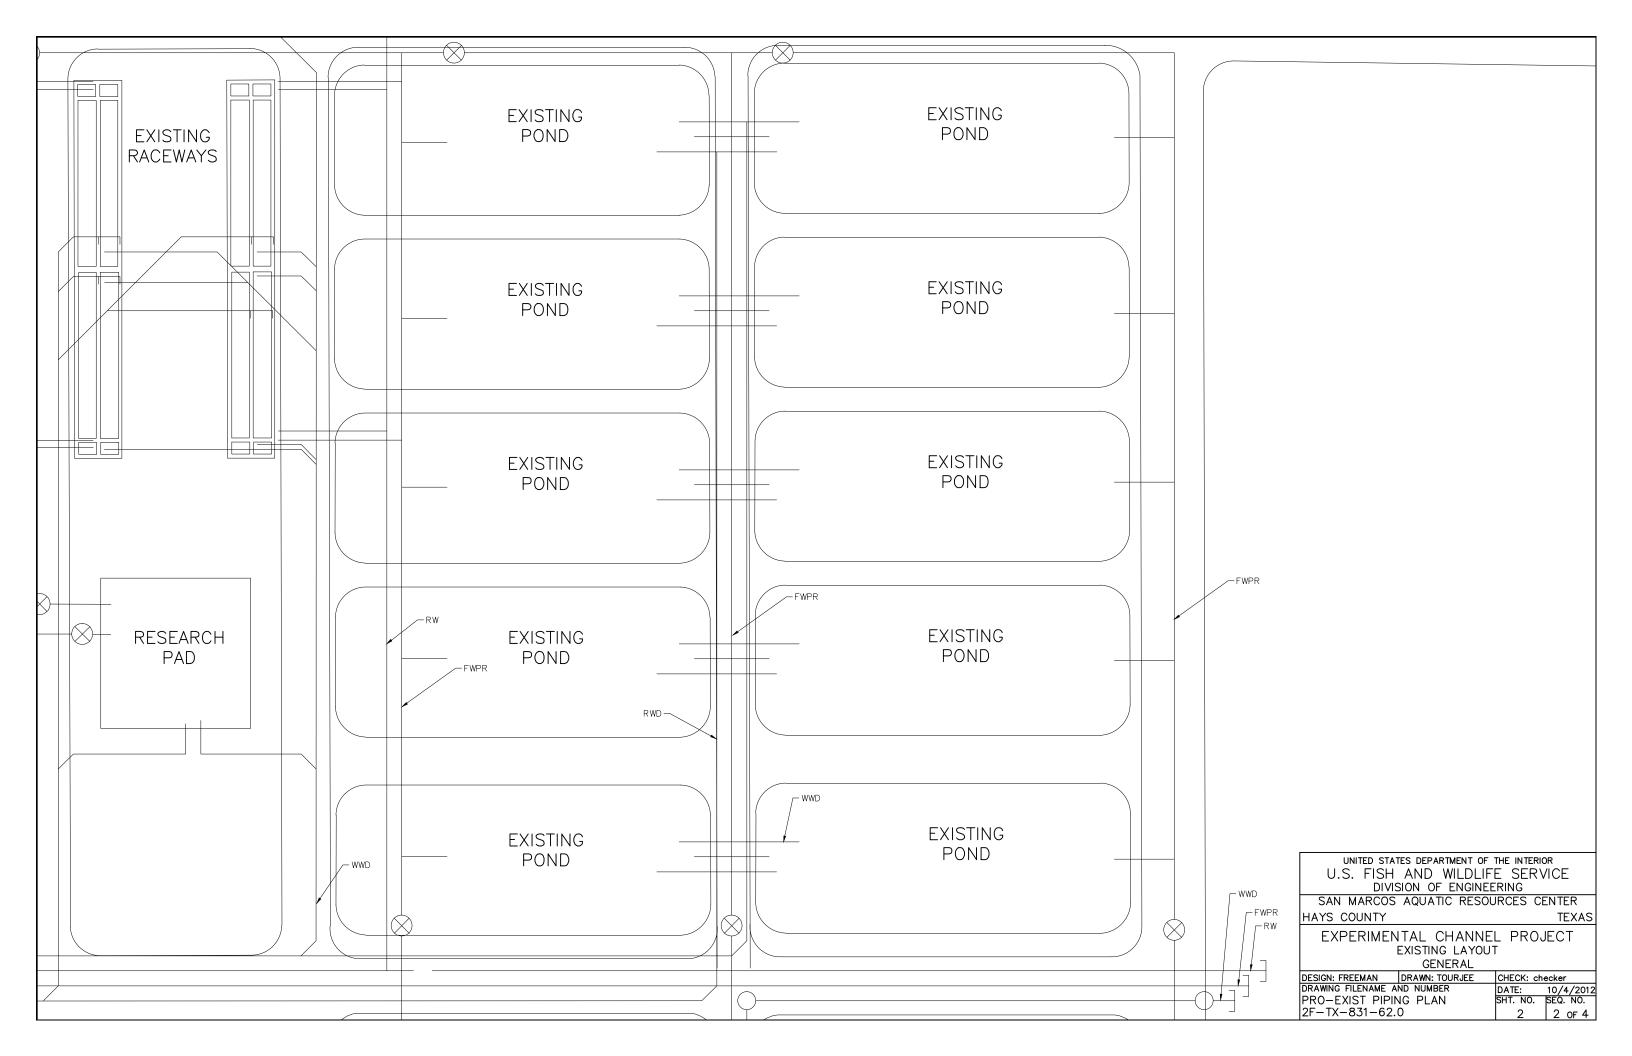


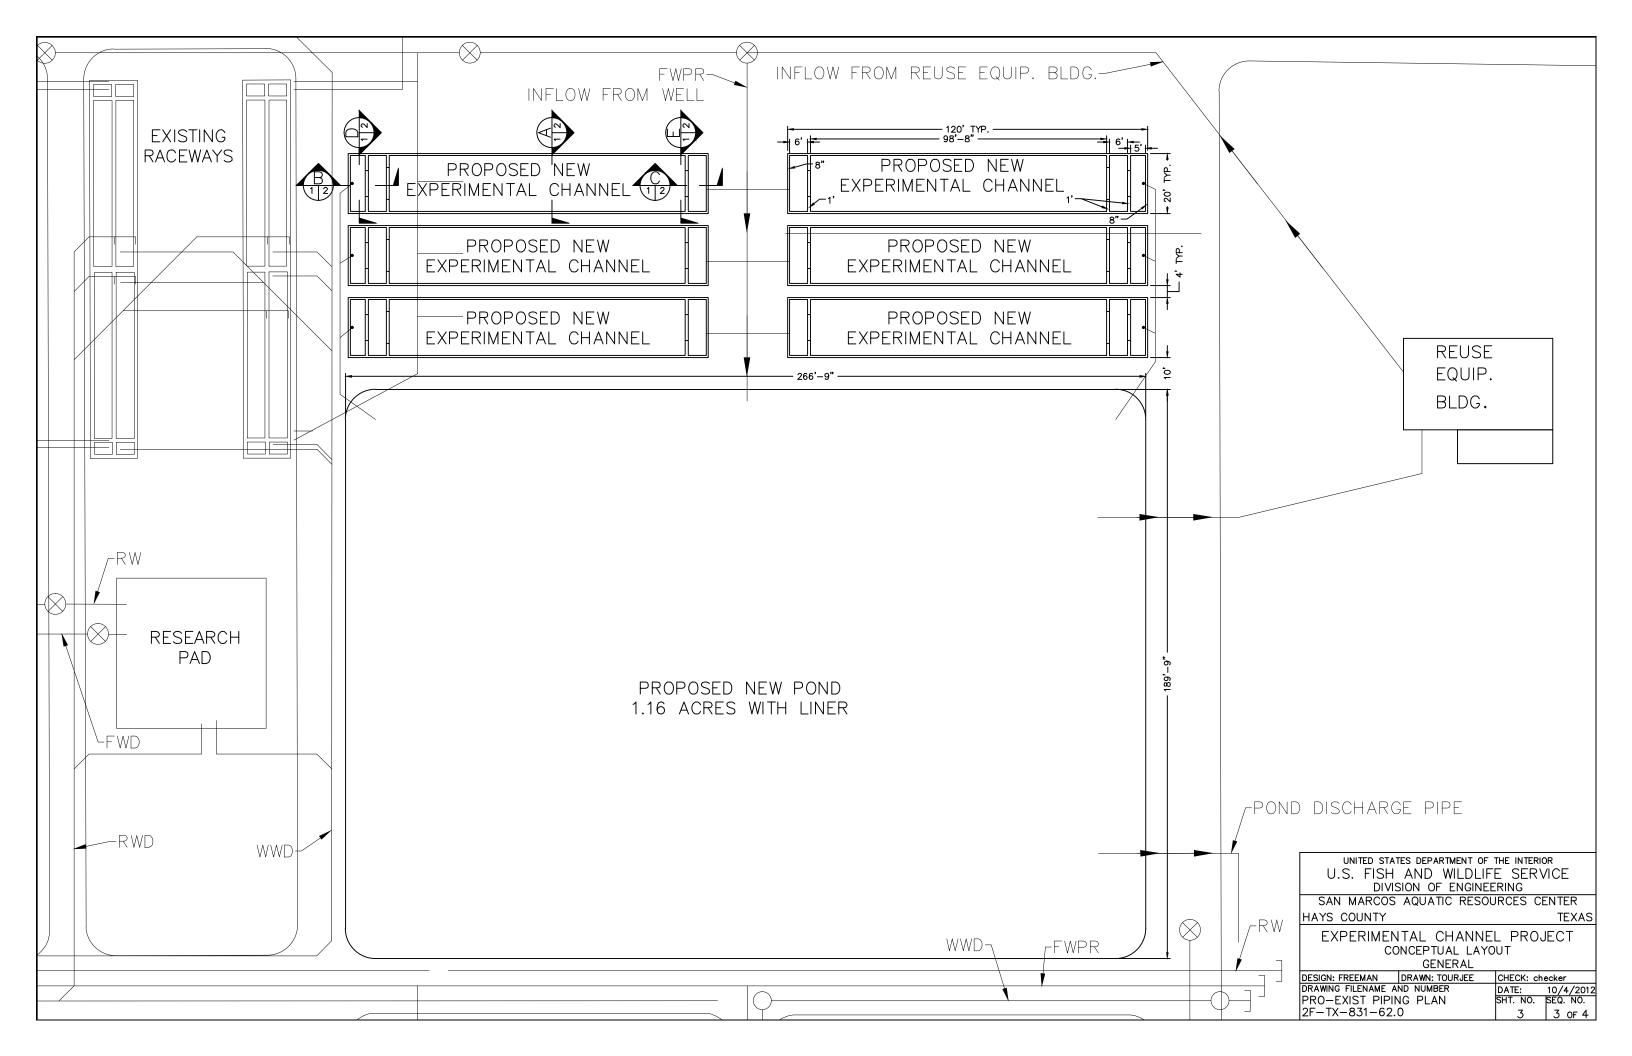


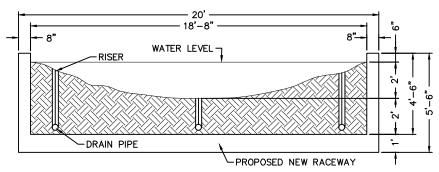


SECTION A PROPOSED NEW RACEWAY OPTION 1.

SCALE: \(\frac{3}{6} \) = 1'-0"

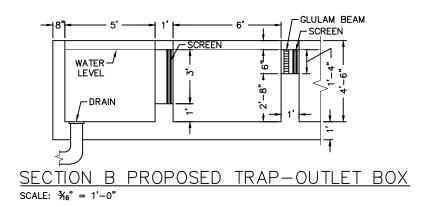

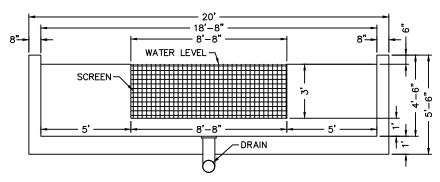


SECTION D PROPOSED TRAP-OUTLET BOX SCALE: %6" = 1'-0"

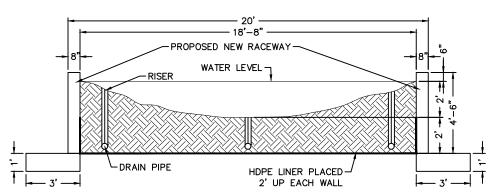


SECTION A PROPOSED NEW RACEWAY OPTION 2.

SCALE: %6" = 1'-0"

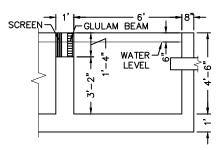

SECTION C PROPOSED INLET BOX SCALE: %6" = 1'-0"

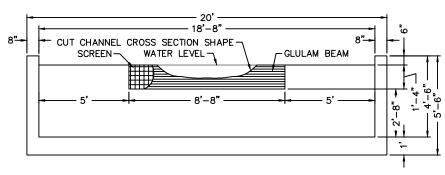

SECTION E PROPOSED INLET BOX SCALE: 3/6" = 1'-0"

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SAN MARCOS AQUATIC RESOURCES CENTER
HAYS COUNTY TEXA

EXPERIMENTAL CHANNEL PROJECT SECTIONS GENERAL

DESIGN: FREEMAN	DRAWN: TOURJEE	CHECK: ch	ecker
DRAWING FILENAME A	ND NUMBER	DATE:	10/4/2012
PRO-EXIST PIPIN	SHT. NO.	SEQ. NO.	
2F-TX-831-62.0	4	4 OF 4	